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01 ADDENDUM INFORMATION 08-10-2023 DESCRIPTION

PURPOSE OF ISSUE:

☐ INFORMATION

REVIEW / APPROVAL PRODUCTION

SHEET CONTENT

MAGNUMSTONE® **GENERAL INFORMATION**

PART 1

SHEET REFERENCE


1100-MS-GEN

DRAWING INFORMATION

AS INDICATED SCALE : PAPER SIZE: 17" WD X 11" HT


PREPARED BY:



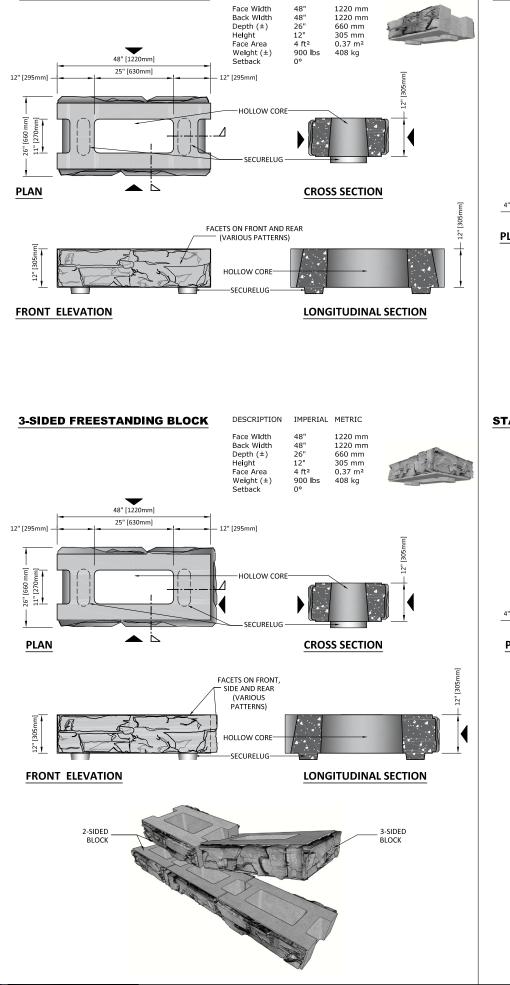


DESCRIPTION IMPERIAL METRIC


2-SIDED FREESTANDING BLOCK

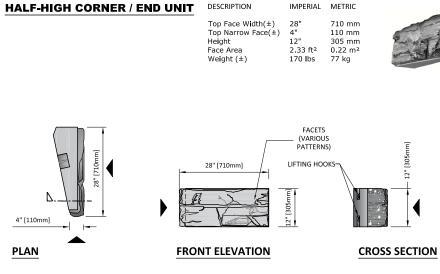



IMPERIAL

METRIC

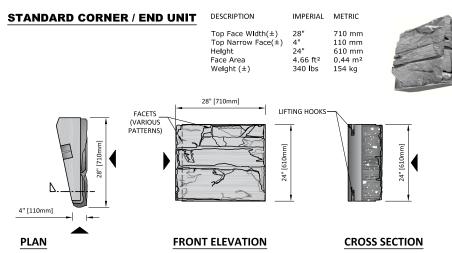

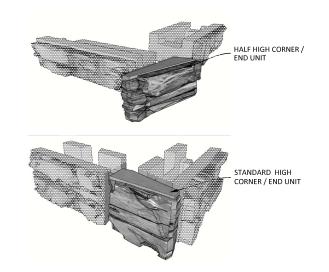


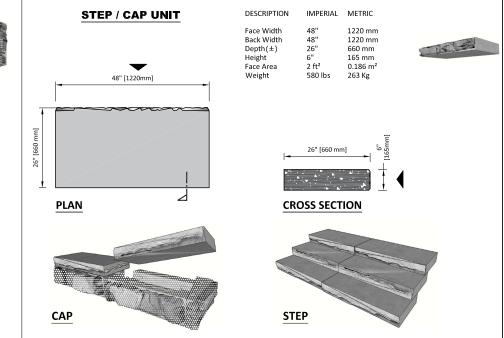

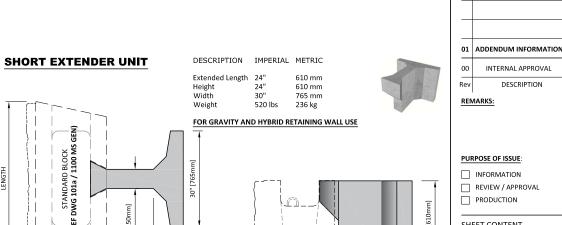

STANDARD BLOCK

ELEVATION

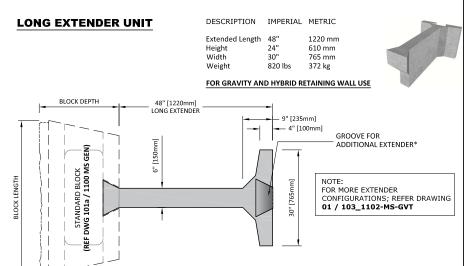

4" [100mm]

DEPTH


PLAN

PLAN

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SHEET CONTENT

MAGNUMSTONE® BLOCK **GENERAL INFORMATION**

PART 2

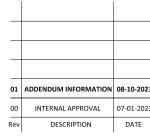SHEET REFERENCE


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DRAWING INFORMATION

SCALE : AS INDICATED PAPER SIZE:

17" WD X 11" HT PREPARED BY:



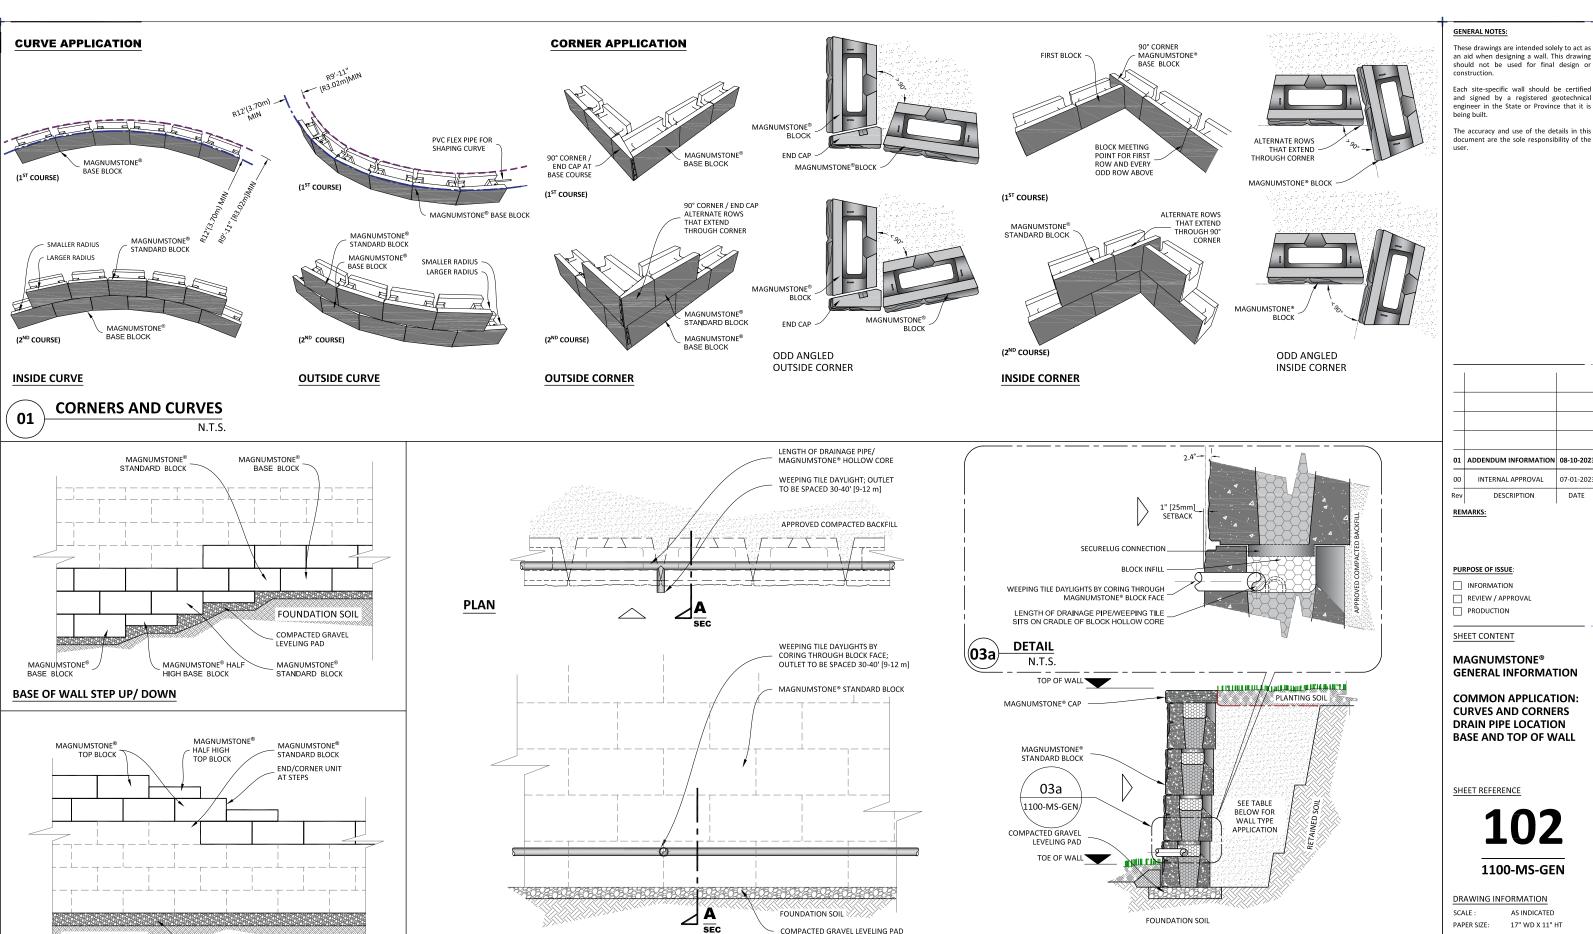

LONGITUDINAL SECTION

03

DRAINAGE PIPE DETAILS

SCALE 1:50

FOUNDATION SOIL

FRONT ELEVATION

N.T.S.

TOP OF WALL STEP UP/ DOWN

02

COMPACTED GRAVEL LEVELING PAD

17" WD X 11" HT PREPARED BY:

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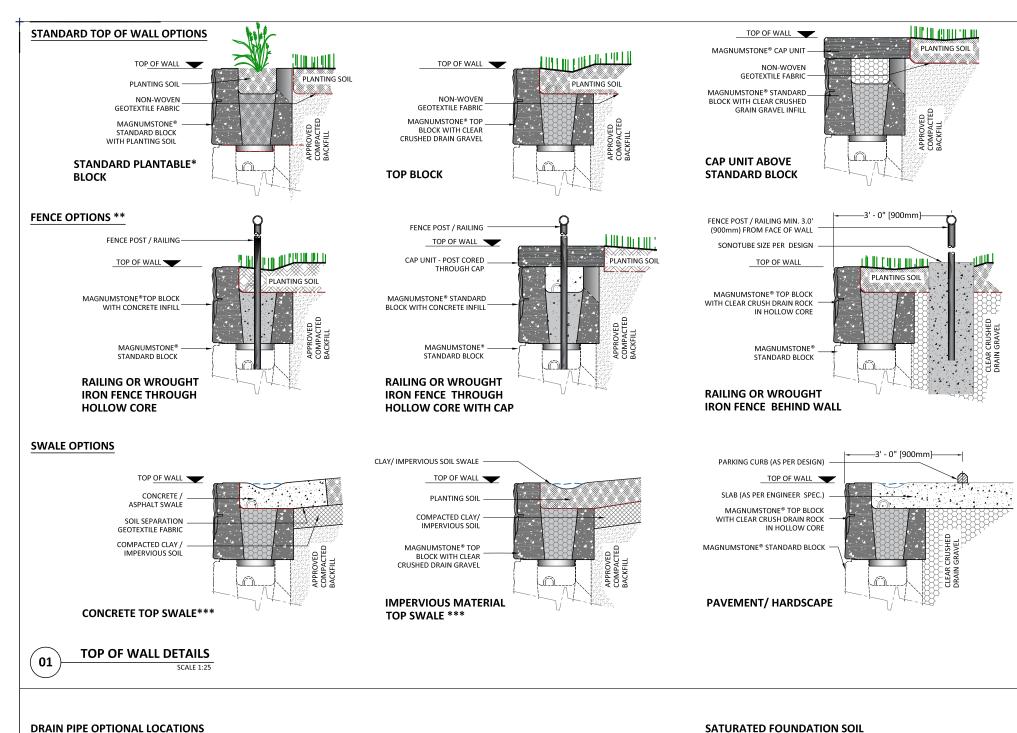
AS INDICATED


DESCRIPTION

DATE

SECTION THROUGH - A


WALL TYPE APPLICATION DESCRIPTION DRAWING REF. NO 1101- MS_GEO GEOGRID RETAINING WALL GRAVITY RETAINING WALL 1102- MS_GVT POSITIVE CONNECTION WALL 1103-MS_PCT 1104-MS PLT PLANTABLE WALL OTHER APPLICATION 1105-MS UCV




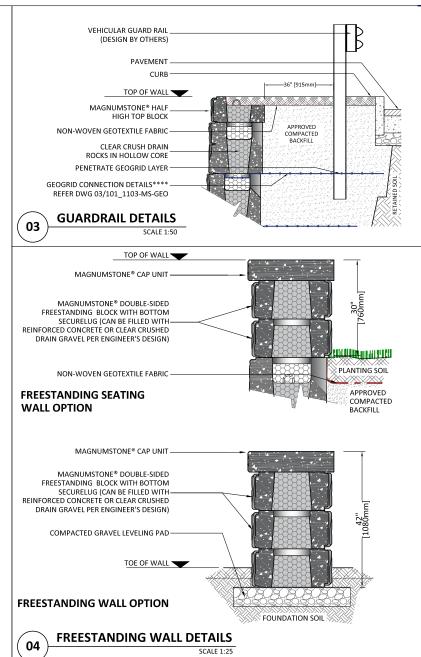




TOE OF WALL DETAILS

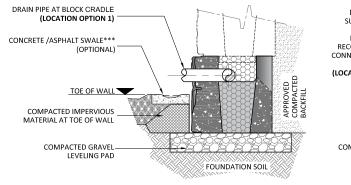

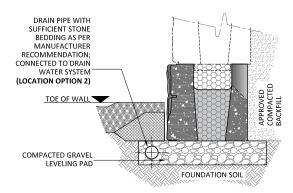

WATER LEVEL (VARIES) RIP-RAF COMPACTED GRAVEL LEVELING PAD BASE STABILIZATION GEOTEXTILE FABRIC (LAYERS PER ENGINEER RECOMMENDATION) FOUNDATION SOIL

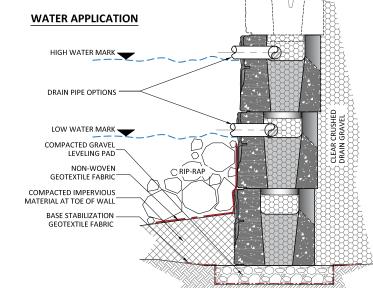

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(*) PLANTABLE GENERAL NOTE

REFER FULL DETAILS ON PLANTABLE WALL AT DRAWING NO. 1104-MS_PLT

(**) FENCE GENERAL NOTE:

FENCE POST / RAILING DESIGN BY OTHERS

DESIGN TO BE PERFORMED BY ENGINEER

(***) SWALE:

DEPTH AND WIDTH OF SWALE TO BE DETERMINED BY ENGINEER

(****) POSITIVE CONNECTION
DETAILS; REFER DWG 03/101_1103-MS-PCT

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DESCRIPTION

DATE

REMARKS:

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SHEET CONTENT

MAGNUMSTONE® GENERAL INFORMATION

COMMON APPLICATIONS TOP OF WALL DETAILS TOE OF WALL DETAILS

1100-MS-GEN

DRAWING INFORMATION

AS INDICATED PAPER SIZE: 17" WD X 11" HT

PREPARED BY:

MagnumStone

- FOR MORE DRAIN PIPE LOCATION OPTIONS OF GRAVITY RETAINING WALLS, PLEASE REFER DRAWING 03 / 103 1102 MS GVT
- DRAIN PIPE LOCATIONS MENTIONED ABOVE ARE POTENTIAL DESIGN SUGGESTIONS. OTHER OPTIONS ARE AVAILABLE AS PER ENGINEER'S DISCRETION
- WEEPING TILE DAYLIGHTS BY CORING THROUGH BLOCK FACE; OUTLET TO BE SPACED 30-40' [9-12 m]





BLOCK INSTALLATION WITH SECURELUG



TOP OF WALL OPTIONS












STEP / CAP CURVE INSTALLATION

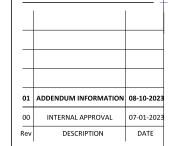

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REMARKS:

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SHEET CONTENT

MAGNUMSTONE® PERSPECTIVE



1100-MS-GEN

DRAWING INFORMATION

AS INDICATED SCALE : 17" WD X 11" HT

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(GEOGRID WALL)



BASE ELEVATION CHANGE

CORNER BLOCK INSTALLATION

FOUNDATION LAYER